#### **ADDENDUM NO. 4**

DATE: July 28, 2023

PROJECT: Village of Gurnee Public Works Material Bin Reconstruction Project

OWNER: VILLAGE OF GURNEE TO: PROSPECTIVE BIDDERS

This Addendum forms a part of the Contract Documents and modifies the Bidding Documents approved for bid, with the amendments as noted below.

This Addendum consists of 3 pages and contains the following revisions:

1. Revisions, clarifications and additions to the Plans and Project Manual

#### CHANGES TO THE CONTRACT DOCUMENTS AND SPECIFICATIONS:

### Item 1: Response to RFI 07/26/2023

- QUESTION: What is the material between the new panel and the new foundation? There is a new asphalt apron around the Material Bins but for installing the new electric feeds to the building, can it be trenched? Or does it need to be saw cut and patched?
- RESPONSE: The existing paved parking lot is asphalt. The electric service installation between the salt dome and the new material bins can be directionally drilled or open cut. If the selected method is open cut, existing pavement must be saw cut and then properly patched prior to asphalt plants closing for the season. Cold patch will not be accepted since this area is directly in front of the entrance to the salt dome and will experience repetitive high loads when salt is loaded/unloaded during snow and ice operations. Hatching has been added to sheet A2-1 to outline the pavement restoration area for an open cut installation.

### Item 2: Response to RFI 07/26/2023


- QUESTION: Does all steel get galvanized per not #12 under "STEEL" on sheet S0-0 or does all steel get painted per the spec in section 09960 on sheet G1-2?
- **RESPONSE:** All steel beams and columns shall be painted per spec section 09960 and not galvanized, however the roof decking would be galvanized.

## <u>Item 3: Modification to Plan Sheet A2-1(see attached)</u>

- Wiring installed from the new panelboard on the existing salt dome to the material storage bin shall be installed in PVC conduit in accordance with Village of Gurnee codes, NOT direct bury
- Conduit shall be 1.5 inches in diameter.
- The wiring within that conduit shall be 4 #8 wire for the receptacles, 2 #10 wire for the lighting and 1 #8 wire for ground.

# ADDENDUM NO. 4

	Heather L. Galan, P.E. Director of Public Works Village of Gurnee
	um by signing below and faxing or emailing a copy or ablic Works Department at (847)-599-6800 or be do may disqualify the Bidder.
Firm	Ву
Name	Title

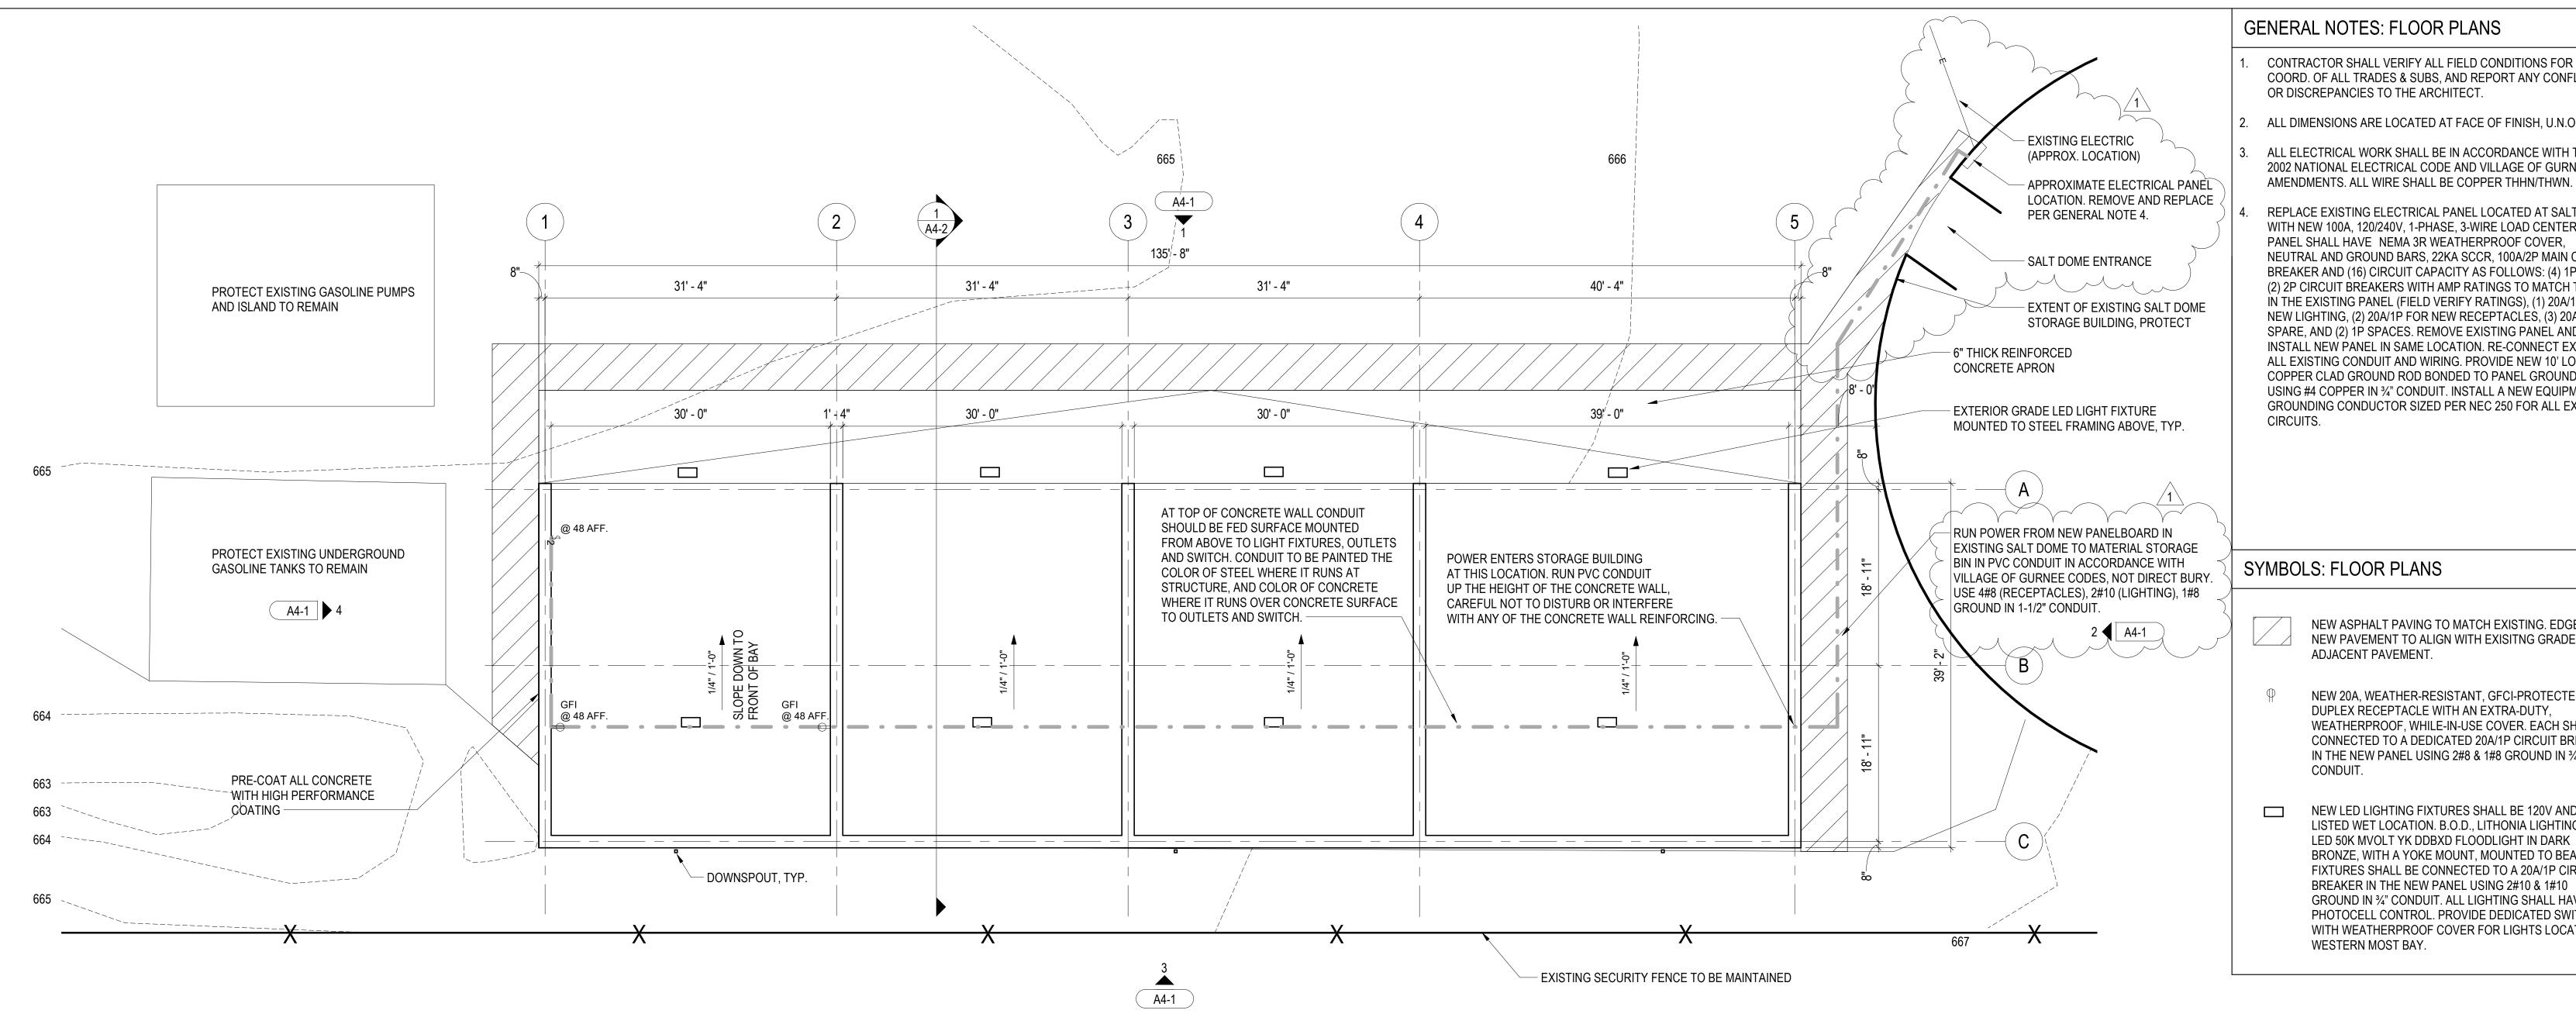

GENERAL NOTES: FLOOR PLANS

- CONTRACTOR SHALL VERIFY ALL FIELD CONDITIONS FOR COORD. OF ALL TRADES & SUBS, AND REPORT ANY CONFLICTS OR DISCREPANCIES TO THE ARCHITECT.
  - ALL DIMENSIONS ARE LOCATED AT FACE OF FINISH, U.N.O.
  - ALL ELECTRICAL WORK SHALL BE IN ACCORDANCE WITH THE 2002 NATIONAL ELECTRICAL CODE AND VILLAGE OF GURNEE
  - REPLACE EXISTING ELECTRICAL PANEL LOCATED AT SALT DOME WITH NEW 100A, 120/240V, 1-PHASE, 3-WIRE LOAD CENTER. PANEL SHALL HAVE NEMA 3R WEATHERPROOF COVER, NEUTRAL AND GROUND BARS, 22KA SCCR, 100A/2P MAIN CIRCUIT BREAKER AND (16) CIRCUIT CAPACITY AS FOLLOWS: (4) 1P AND (2) 2P CIRCUIT BREAKERS WITH AMP RATINGS TO MATCH THOSE IN THE EXISTING PANEL (FIELD VERIFY RATINGS), (1) 20A/1P FOR NEW LIGHTING, (2) 20A/1P FOR NEW RECEPTACLES, (3) 20A/1P SPARE, AND (2) 1P SPACES. REMOVE EXISTING PANEL AND RE-INSTALL NEW PANEL IN SAME LOCATION. RE-CONNECT EXISTING ALL EXISTING CONDUIT AND WIRING. PROVIDE NEW 10' LONG, 3/4" COPPER CLAD GROUND ROD BONDED TO PANEL GROUND BUS USING #4 COPPER IN 3/4" CONDUIT. INSTALL A NEW EQUIPMENT GROUNDING CONDUCTOR SIZED PER NEC 250 FOR ALL EXISTING CIRCUITS.

SYMBOLS: FLOOR PLANS

- NEW ASPHALT PAVING TO MATCH EXISTING. EDGE OF NEW PAVEMENT TO ALIGN WITH EXISITNG GRADE OF ADJACENT PAVEMENT.
- NEW 20A, WEATHER-RESISTANT, GFCI-PROTECTED DUPLEX RECEPTACLE WITH AN EXTRA-DUTY, WEATHERPROOF, WHILE-IN-USE COVER. EACH SHALL BE CONNECTED TO A DEDICATED 20A/1P CIRCUIT BREAKER IN THE NEW PANEL USING 2#8 & 1#8 GROUND IN 3/4" CONDUIT.
- NEW LED LIGHTING FIXTURES SHALL BE 120V AND UL LISTED WET LOCATION. B.O.D., LITHONIA LIGHTING TFX1 LED 50K MVOLT YK DDBXD FLOODLIGHT IN DARK BRONZE, WITH A YOKE MOUNT, MOUNTED TO BEAM. ALL FIXTURES SHALL BE CONNECTED TO A 20A/1P CIRCUIT BREAKER IN THE NEW PANEL USING 2#10 & 1#10 GROUND IN 3/4" CONDUIT. ALL LIGHTING SHALL HAVE PHOTOCELL CONTROL. PROVIDE DEDICATED SWITCH WITH WEATHERPROOF COVER FOR LIGHTS LOCATED IN WESTERN MOST BAY.

www.holabird.com

HOLABIRD & ROOT

140 South Dearborn Chicago, IL 60603

Tel: 312 357 1771 Fax: 312 357 1909



Holabird & Root, LLC expressly disclaims any responsibility arising from any unauthorized use of these plans, drawings and notes. Any authorization must be in

This drawing copy may have been reproduced at a size different than originally drawn. The Owner and Architect assume no responsibility for use of incorrect scale. Drawings are not to be scaled.

Not published - All rights reserved.

2	07/27/2023	ADDENDUM NO. 4
1	06/23/2023	ISSUE FOR BID/ PERMIT
No.	Date	Issue

		Project Number	16065
		Drawn	D. PORTH
		Checked	A. STRANE
		Proj. Arch./Eng.	G. GRUNLOH
ı			·



Village of Gurnee Public Works Material Bin Reconstruction Project


1151 Kilbourne Rd, Gurnee, IL 60031

Project Name

FLOOR PLAN AND ROOF PLAN

Sheet Name

Drawing No. A2-1

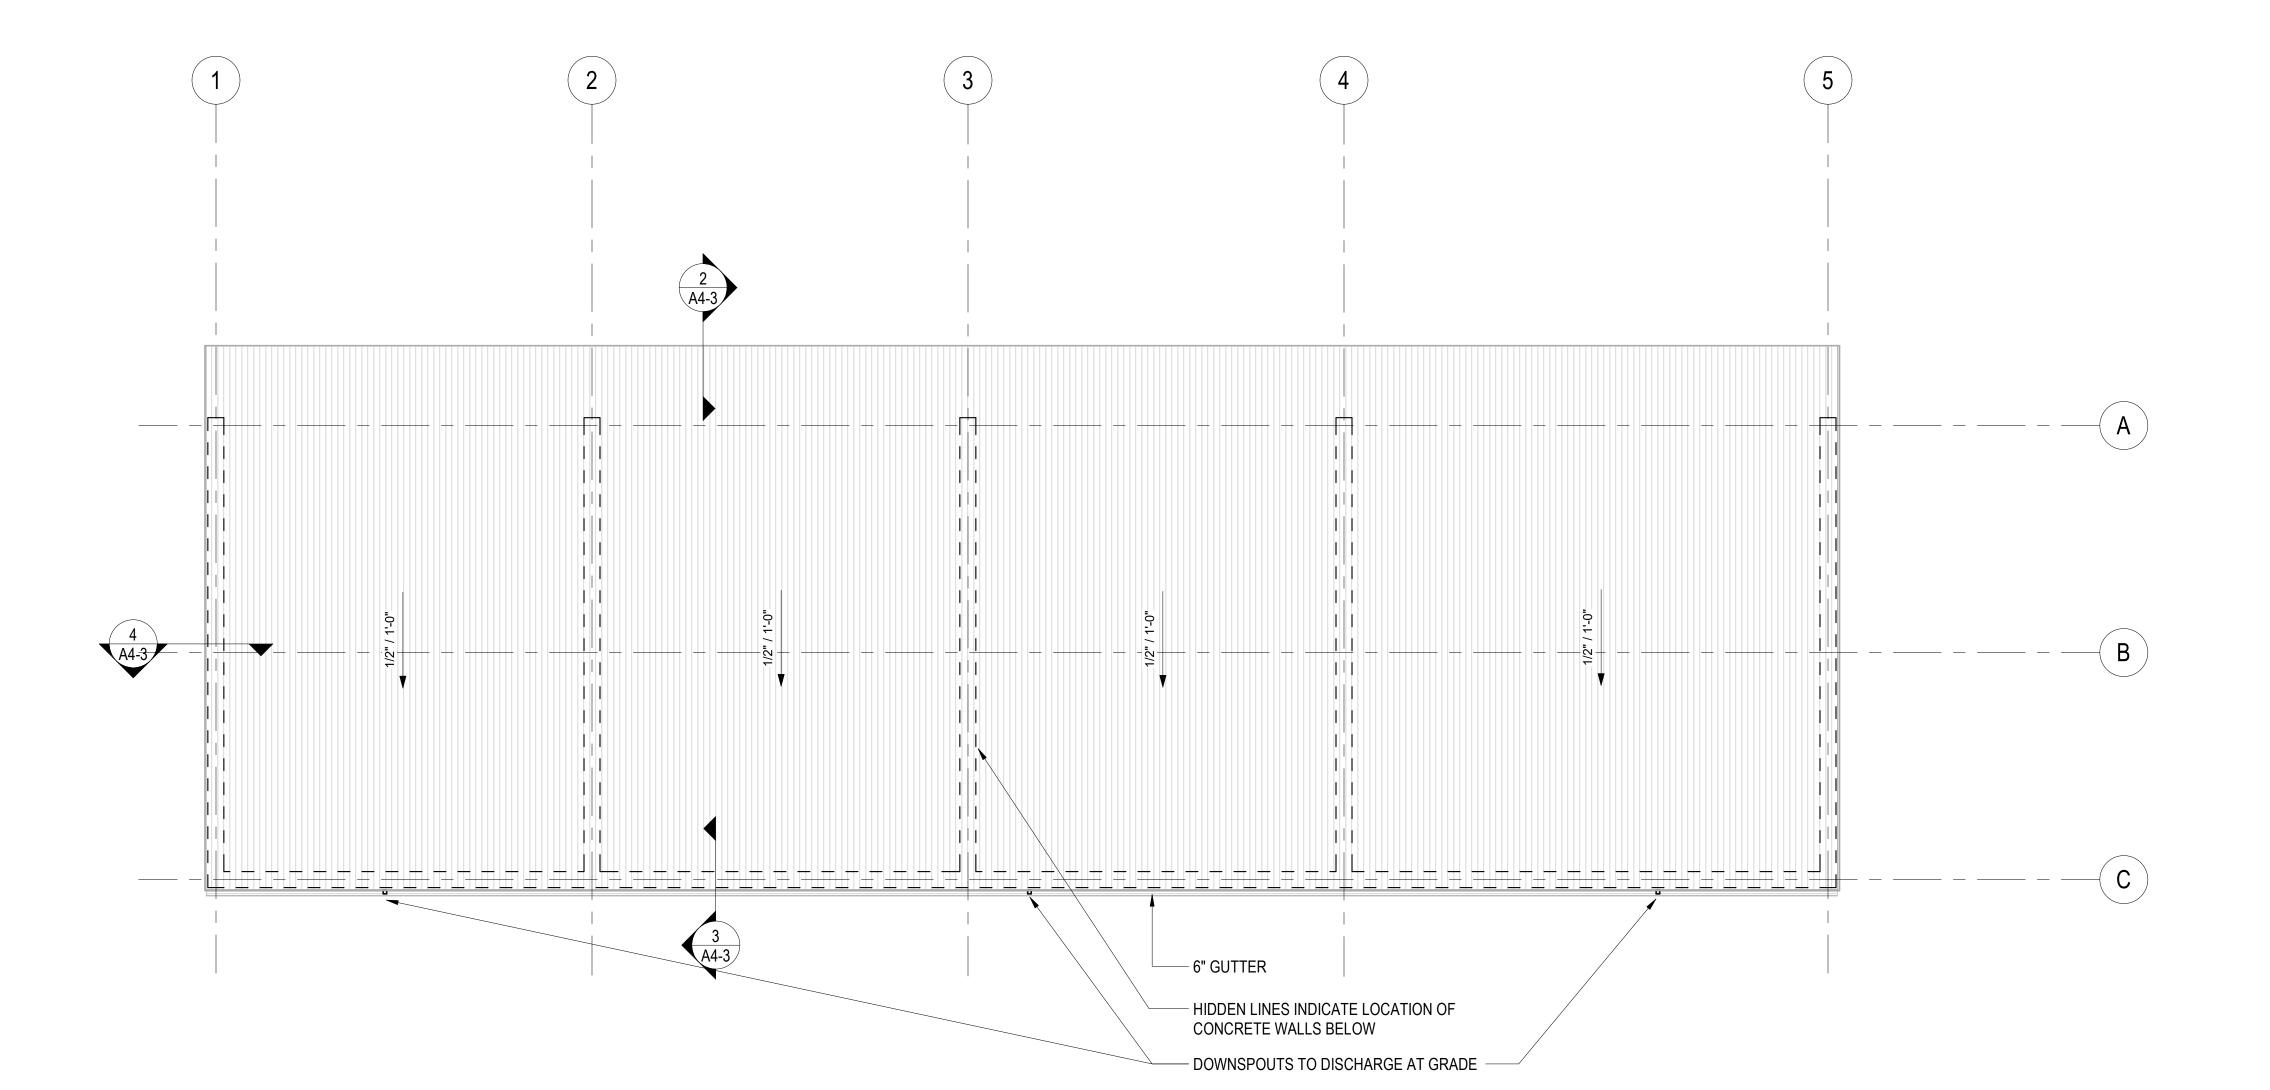

2 ROOF PLAN A2-1 1/8" = 1'-0"

FLOOR PLAN

1 FLOOR F A2-1 1/8" = 1'-0"